

ADDENDUM # 001

St. Clair Catholic District School Board

Holy Trinity Catholic School 60 Lorne Crescent Sarnia, Ontario

Site and Parking Lot Improvement Work

Project No. 651-CP1607

Prepared by:

Randy Wilson Architect Inc. 280 Queens Ave, Suite 1Q London, Ontario N6B 1X3

May 2016

This addendum forms part of the Contract Bid Documents and amends the original drawings and specifications issued for Bid on May 9th. 2016.

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ADDENDUM # 1 (Including cover)

4 Page(s)

Attachments forming part of this addendum

Revised Architectural Drawings New Civil Drawings 1 sheets 2 sheets

TOTAL PAGE COUNT FOR THIS ADDENDUM

7 Page(s)

PART A – GENERAL

1.1 SITE MEETING/REVIEW

- a. The mandatory site review was held on May 12th. 2016..
 - i. Attached is the attendee list of the Mandatory Site Meeting. Please note that representatives from Contractors that were in attendance at this mandatory pre-bid walkthrough and have complied with the submission of the Bidders Registration Form are therefore the only Contractors able to submit bids for this project.
 - ii. The contractor is responsible for all construction damage incurred on site and to the school property.
 - iii. Special considerations noted included expectations regarding conduct on site. As the construction site will be on a school property, the following points were made:
 - All people working on site must have a particular awareness of the safety and protection of children and school staff. Workers must work safely.
 - 2. The work site must be kept safe and secure by ensuring all safety precautions are taken and the worksite be kept tidy.
 - 3. The work site has a no smoking policy, a zero tolerance harassment policy and language is to be monitored at all times.
 - iv. As noted in the bid documents, the contractor is to work with the Board to establish a schedule of work that complies with the schedule milestones stated in the Bid Documents.
 - v. Any sub-trades may bid to the prescribed General Contractors.
 - vi. General expectations were discussed about the extent of work as follows:
 - 1. The review included the distribution of Civil drawings as indicated in the bid Notice of Project.
 - 2. The review provided a general commentary about the complete removal of an existing portion of asphalt, curbing, existing garbage enclosures and removal of lighting bases while maintaining light poles and fixtures for reuse.
 - 3. Lowering the demolished parking area to match finished elevations as stated on Civil drawings, providing granular material and milling existing asphalt to match all asphalt surfaces.
 - 4. Remove all goal posts for later reuse in areas affected by the work.

- Provide excavation of materials while saving existing trees along eastern area of work. Prepare area for the placement of engineered fibre mulch. Mulch supply and install is carried in cash allowance work.
- 6. Provide all fencing demolition, temporary fencing and permanent fencing as delineated on the drawings.
- 7. Provide all new surfaces, parking area, sidewalks and restorations as delineated on the drawings.
- 8. Provide new lighting bases and new conduit for revised power feeds as indicated on the architectural A010 drawing. Provide licensed electrician to identify live power feeds to parking light back to the main panel. Provide lock out of circuits for safe rework of the parking lot lighting. Provide new electrical tie in of new parking lot lighting through underground conduit. Provide TSA inspection of all electrical work prior to re-energizing circuit to parking lot lighting.
- 9. There was a review of the new requirements for garbage and recycling on the east side of the school.
- 10. The east property line requirements were reviewed along with areas of asphalt and subbase removal and restoration to grass.
- vii. It was noted that the documents call for one year maintenance of landscaping. The intent of the documents is to ensure that all grass areas are well established prior to turn over to the board.

Holy Trinity Site and Parking Lot Improvement Tender Bid Mandatory Site Visit List

Company	Contractor	Email Address	Phone
	Name		Number
Sevcon Paving	Ric Dauw	ric.sevconpaving@cogeco.net	519-490-5007
B.H.G.C.	Bill Hoekstra	info@bh-gc.com	519-344-4855
C + C Construction	Daniel Clacys	estimator@ccconstr-eng.com	519-336-3430
Cope Construction	Jeff DeRush	jderush@cope.on.ca	519-268-8231
First General	Jeff Medeiros	jeffmedeiros@firstgeneral.com	519-332-2300

1.2 TENDER QUESTION(S)

a. <u>Question</u>: There are two light base drawings, one on the A010 and another on C-1, which one has precedence?

Answer: The one indicated on C1 is the correct light base detail.

End of Minutes

PART B - SPECIFICATIONS

Not Applicable

PART C - ARCHITECTURAL DRAWINGS

A-010 - COVER SHEET, KEY PLAN

Revisions for Addendum #1 clouded and noted.

PART D - STRUCTURAL DRAWINGS

RESERVED

PART E - MECHANICAL / ELECTRICAL DRAWINGS

RESERVED

PART F - CIVIL ENGINEERING DRAWINGS


C1 - Notes, Legend, Details and Plan - Issued with this Addendum

C2 – Partial Site Engineering Plans – Issued with this Addendum

Architectural Sketches Included

N/A

END OF ADDENDUM # 001

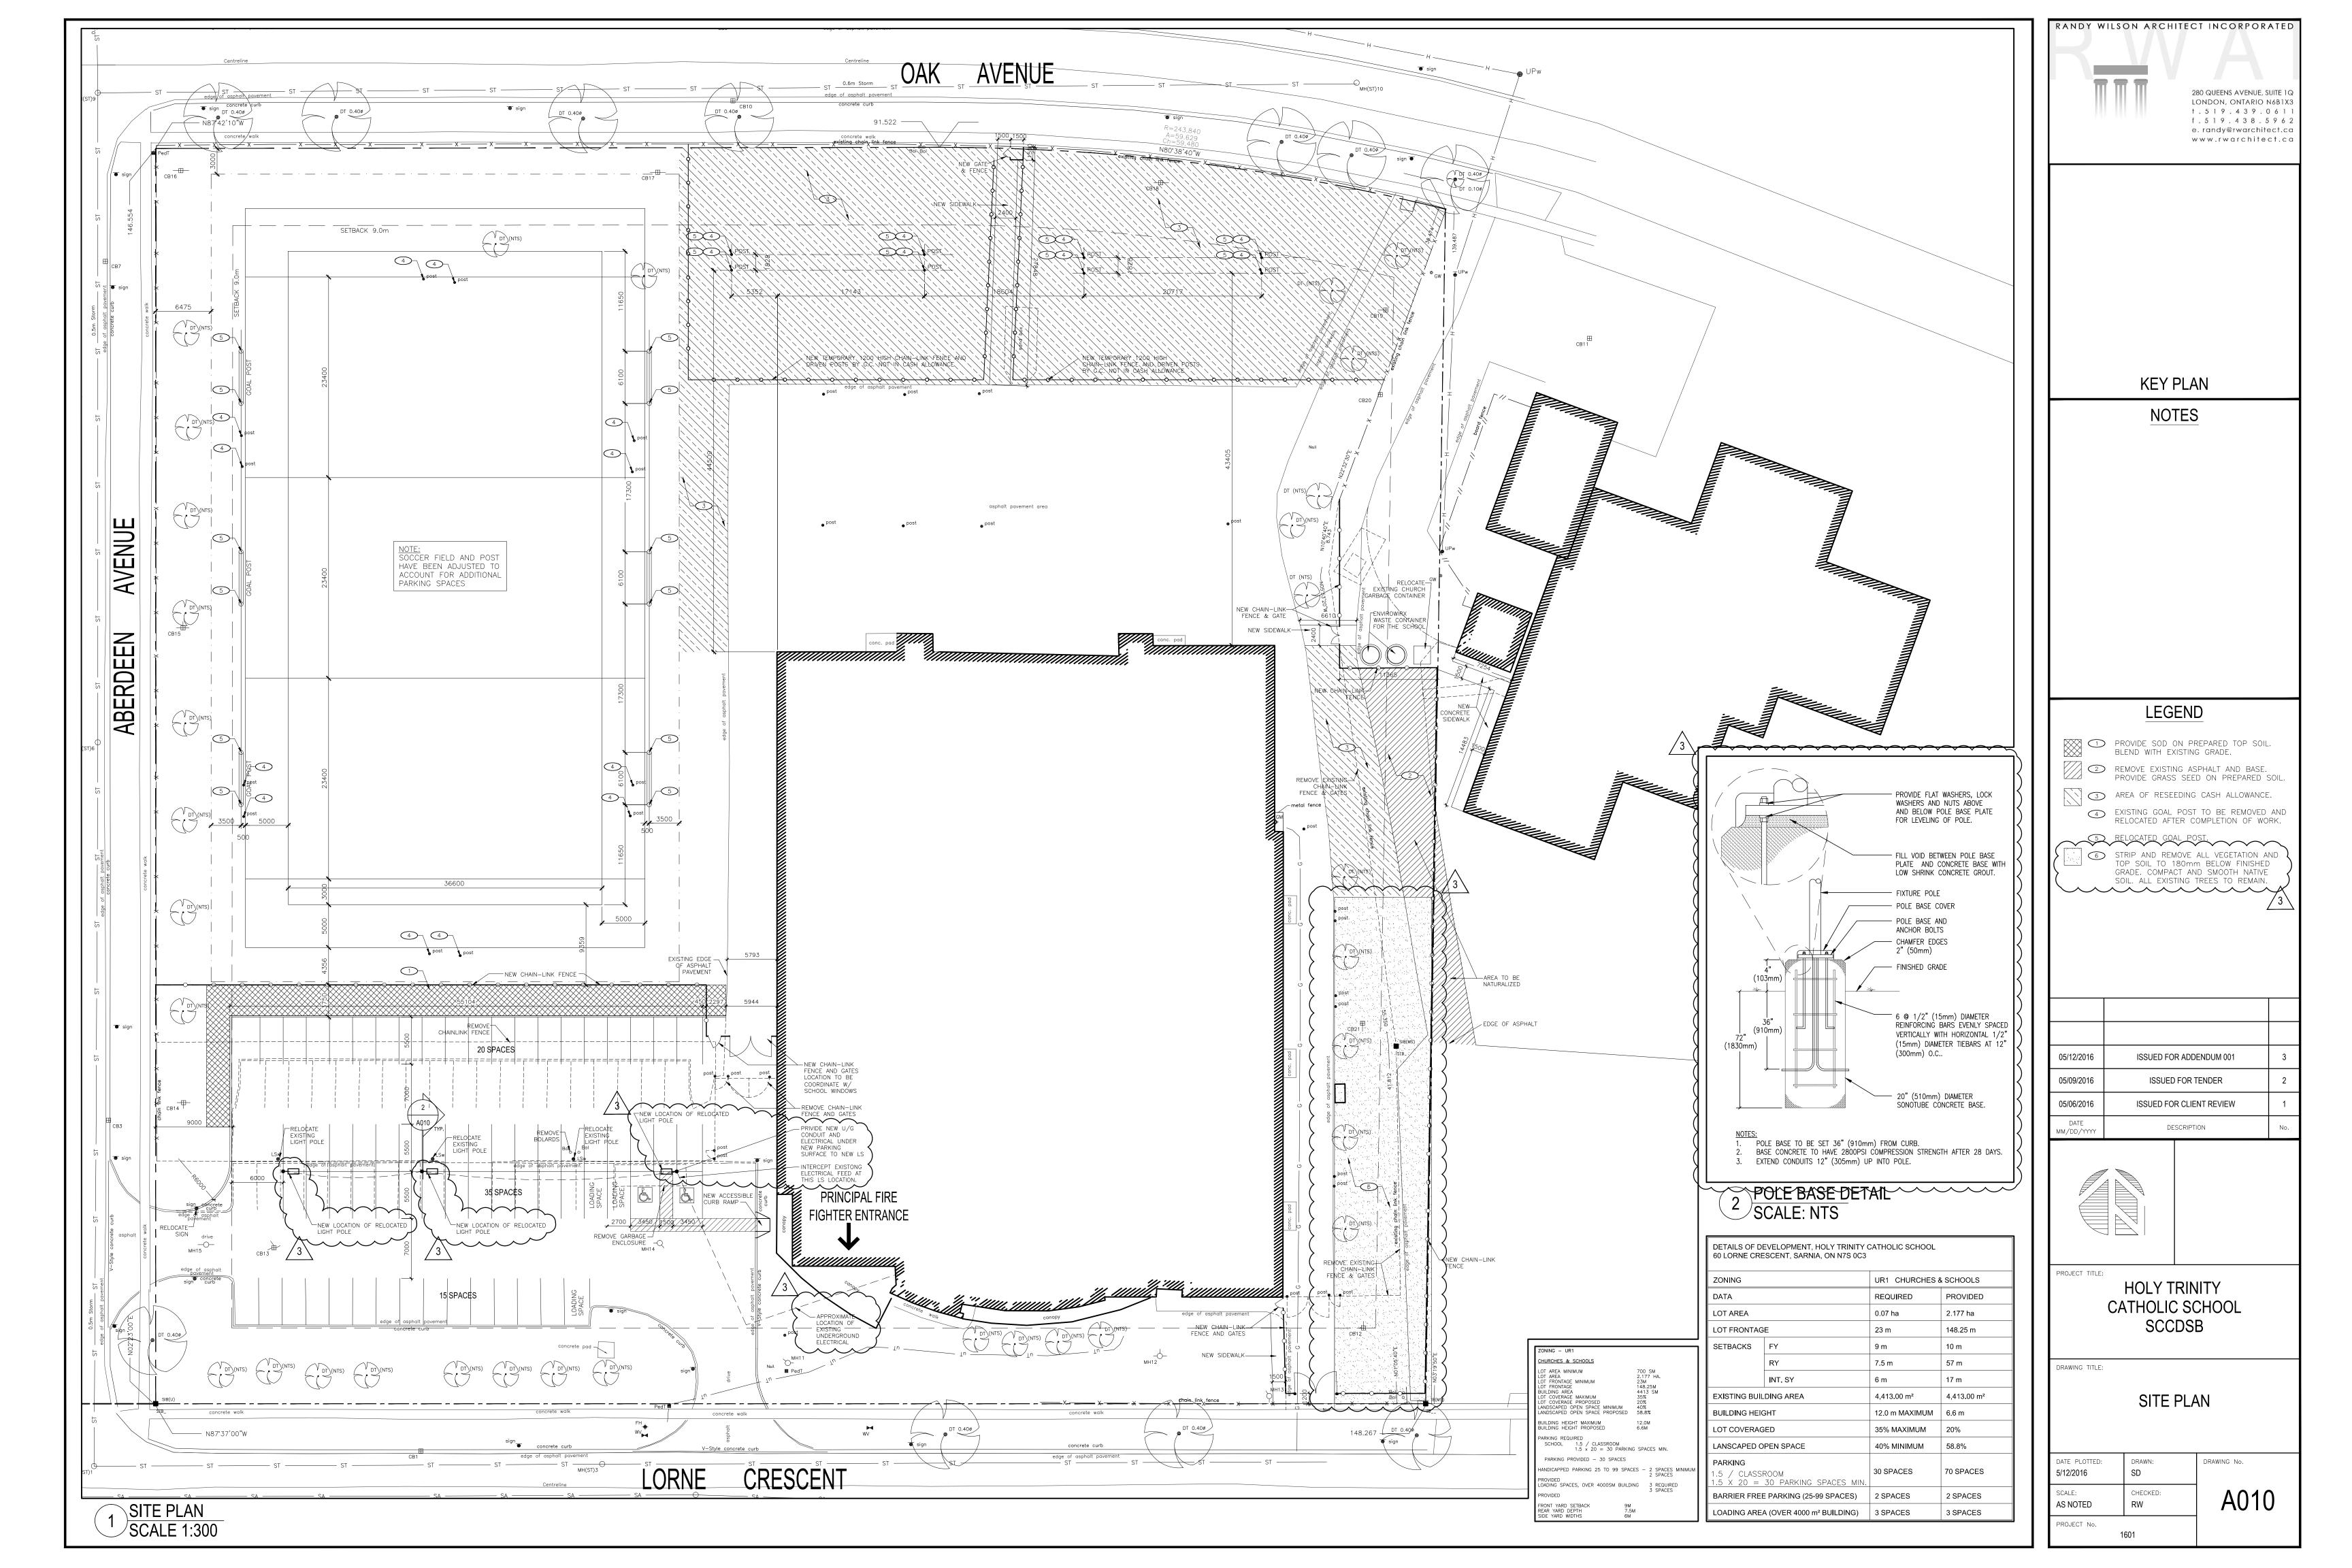

GENERAL NOTES:

- . THE OWNER'S PROFESSIONAL ENGINEER IS REQUIRED TO INSPECT THE INSTALLATION OF SERVICES AND FINAL GRADING INCLUDED IN THIS PROJECT IN ACCORDANCE WITH THE GENERAL REVIEW COMMITMENT CERTIFICATION PROCESS. THE CONTRACTOR IS TO PROVIDE AT LEAST 48 HOURS PRIOR TO ANY REQUIRED INSPECTION.
- . ALL WORK SHALL BE DONE IN ACCORDANCE WITH THE MINIMUM STANDARDS AND SPECIFICATIONS OF THE MUNICIPALITY. SBM LTD. IS NOT RESPONSIBLE FOR THE INFORMATION (EXISTING TOPOGRAPHY, BENCHMARKS, PROPERTY BOUNDARY, ETC.) PROVIDED BY OTHERS.

CONSTRUCTION NOTES:

- REFER TO THE SITE PLAN FOR LAYOUT, DIMENSIONING, AND SIGN/POST/FENCE DETAILS.
- THE CONTRACTOR IS TO CONTACT THE CONSULTING ENGINEER FOR FINAL INSPECTION. . THE CONTRACTOR SHALL TAKE ALL PRECAUTIONARY MEASURES UNDER THE OCCUPATIONAL HEALTH AND SAFETY ACT AS REQUIRED BY THE MINISTRY OF LABOUR.
- 4. THE CONTRACTOR IS TO REVIEW AND CONFIRM ALL EXISTING CONDITION INFORMATION & INFORM SBM ENGINEERING LTD. OF ANY DISCREPANCIES PRIOR TO CONSTRUCTION, SBM ENGINEERING LTD. IN NO WAY ACCEPTS RESPONSIBILITY FOR ANY INACCURACIES FOUND ON THIS PLAN RELATIVE TO EXISTING CONDITIONS FOR
- . PRIOR TO COMMENCING ANY CONSTRUCTION, ALL SEWER OUTLET INFORMATION, BENCHMARKS, ELEVATIONS, DIMENSIONS, GRADES, ETC. MUST BE CHECKED BY THE
- CONTRACTOR AND VERIFIED AND ANY DISCREPANCIES REPORTED TO THE CONSULTING ENGINEER. . PRIOR TO COMMENCING ANY WORK ON THE INSTALLATION OF SERVICES & GRADING, AN APPROVED SET OF PLANS AND SPECIFICATIONS MUST BE AVAILABLE ON THE
- JOB AND SHALL REMAIN THERE WHILE WORK IS BEING DONE. 7. STRIP FULL DEPTH OF TOPSOIL IN AREAS TO BE DISTURBED AND STOCK PILE FOR RE—USE IN GRASSED/LANDSCAPED AREAS. 3. CONTRACTOR IS RESPONSIBLE FOR ALL AS—BUILT INVERTS AND GRADES, RECORD ANY DEVIATION OF PIPE OR STRUCTURE LOCATION INVOLVED WITH THIS PROJECT
- AND CONTRACTOR TO PROVIDE A COPY OF THE AS-BUILT DRAWING SHOWING ALL CHANGES CLEARLY MARKED IN RED. 9. THE CONTRACTOR SHALL CONSTRUCT TEMPORARY MEASURES TO CONTROL SILT ENTERING THE STORM DRAINAGE SYSTEM TO THE SPECIFICATIONS OUTLINED IN THE GUIDELINES ON EROSION AND SEDIMENT CONTROL FOR URBAN CONSTRUCTION SITES PREPARED BY THE MINISTRY OF NATURAL RESOURCES. THESE MEASURES ARE TO BE INSTALLED PRIOR TO COMMENCING ANY CONSTRUCTION FOR THIS PROJECT AND ARE TO REMAIN IN PLACE UNTIL CONSTRUCTION HAS BEEN COMPLETED TO
- BASE ASPHALT AND SOD OR THE SATISFACTION OF THE MUNICIPALITY'S ENGINEER. 10. THE CONTRACTOR IS RESPONSIBLE FOR: 10.1. CONNECTING ANY EXISTING SEWER OR DRAIN ENCOUNTERED DURING CONSTRUCTION TO A NEW SEWER OF SIMILAR TYPE, SIZE AND MATERIAL OR INTO
- ANOTHER EXISTING SEWER OF THE SAME TYPE. 10.2. ENSURING THAT THERE IS NO INTERRUPTION OF ANY SURFACE OR SUBSURFACE DRAINAGE FLOW THAT WOULD ADVERSELY AFFECT NEIGHBOURING PROPERTIES. 11. NO FOUNDATION DRAIN CONNECTIONS WILL BE PERMITTED INTO THE SANITARY SEWERS AND NO DIRECT GRAVITY CONNECTIONS FROM THE FOUNDATION DRAINS WILL BE PERMITTED TO THE STORM SYSTEM UNLESS THE STORM SYSTEM HAS THE CAPACITY TO PROVIDE FOR SUCH CONNECTIONS TO THE SATISFACTION OF THE
- 12. WORK ON OR ADJACENT TO THE MUNICIPAL R.O.W. SHALL BE COMPLETED IN ACCORDANCE WITH THE ONTARIO TRAFFIC MANUAL BOOK 7 LATEST EDITION.

UTILITIES NOTES:

- THE UTILITIES PROVIDERS MUST BE INFORMED AT LEAST TWO WEEKS PRIOR TO CONSTRUCTION ON ANY EXISTING MUNICIPAL ROAD ALLOWANCE, ALL EXISTING UNDERGROUND SERVICE OR UTILITIES WITHIN THE LIMITS OF THE CONSTRUCTION SITE SHALL BE LOCATED AND MARKED. ANY UTILITIES, DAMAGED OR DISTURBED DURING CONSTRUCTION, SHALL BE REPAIRED OR REPLACED TO THE SATISFACTION OF THE GOVERNING BODY AT THE CONTRACTOR'S EXPENSE.
- ALL EXISTING UNDERGROUND UTILITY (TELEPHONE, HYDRO, GAS, CABLE, SEWER, WATERMAINS, ETC.) THAT WILL BE CROSSED UNDER DURING THE INSTALLATION OF SERVICES FOR THIS DEVELOPMENT SHALL BE SUPPORTED, AS MAY BE REQUIRED BY THE OWNERS OF THE UTILITY BEING CROSSED UNDER.
- CONTRACTOR TO VERIFY LOCATION OF ALL EXISTING UTILITIES PRIOR TO CONSTRUCTION. CONTRACTOR TO COORDINATE WITH UTILITIES PROVIDER FOR BRACING, DECOMMISSIONING AND/OR RELOCATION OF EXISTING GAS, HYDRO, TELEPHONE, CABLE, ETC. SERVICES, IF REQUIRED.

RESTORATION NOTES:

- ALL SURFACES WHICH ARE DISTURBED DURING CONSTRUCTION SHALL BE RESTORED TO A CONDITION AT LEAST AS GOOD AS ORIGINAL, OR AS PER BELOW (WHICHEVER IS GREATER) OR IF WITHIN THE MUNICIPAL RIGHT-OF-WAY TO THE SATISFACTION OF THE MUNICIPAL ENGINEER, ALL AT NO COST TO THE MUNICIPALITY; 1.1. GRASSED AREAS TO BE RESTORED w/ 100mm TOPSOIL + SOD
- 1.2. CONCRETE SIDEWALK TO OPSD 310.010 'CONCRETE SIDEWALK'.
- 1.3. CONCRETE CURB AND GUTTER TO OPSD 600.110 'CONCRETE BARRIER CURB'. 1.4. ASPHALT AREA SHALL BE RESTORED AS FOLLOWS:
 - 1.4.1. PROOF ROLL SUBGRADE (TO THE SATISFACTION OF THE GEOTECHNICAL ENGINEER) PRIOR TO PLACEMENT OF GRANULARS (98% SPMDD MIN.). 1.4.2. MILL ADJACENT ASPHALT TO BE TIED INTO 50mm DEEP x 500mm WIDE PRIOR TO RESTORATION SEE DETAIL ON SHEET C1.
 - 1.4.3. MIN. RECOMMENDED ON-SITE LIGHT-DUTY PAVEMENT STRUCTURE (TO BE REVIEWED & APPROVED BY THE GEOTECHNICAL ENGINEER)
 - 40mm HL3 SURFACE ASPHALT COMPACTED TO 97% MARSHALL MIX DESIGN BULK DENSITY - 50mm HL8 BINDER ASPHALT COMPACTED TO 97% MARSHALL MIX DESIGN BULK DENSITY
 - ASPHALT TO BE SUPPLIED AND PLACED IN ACCORDANCE WITH OPSS 310 & 1150
 - 150mm OF GRANULAR 'A' COMPACTED TO 100% SPMDD - 300mm OF GRANULAR 'B' COMPACTED TO 100% SPMDD
- 1.5. RESTORE ALL PAVEMENT MARKINGS TO MATCH EXISTING PRE-CONSTRUCTION CONDITIONS AND MARKINGS SHALL BE COMPLETED IN ACCORDANCE WITH OPSS 710 'CONSTRUCTION SPECIFICATION FOR PAVEMENT MARKING'. 1.6. ALL EXTERIOR HORIZONTAL CONCRETE SHALL BE 32 MPg AT 28 DAYS c/w 5-8% AIR ENTRAINMENT.
- 2. ALL AREAS OUTSIDE THE CONSTRUCTION LIMITS SHALL NOT BE DISTURBED. ANY DAMAGED TO THOSE AREAS ARE TO BE REPAIRED AT THE CONTRACTORS EXPENSE TO THE EXISTING CONDITIONS, OR ABOVE NOTED SPECIFICATIONS, WHICHEVER IS GREATER.

OPSD

SEDIMENT & EROSION CONTROL MEASURES:


- PROTECT ALL EXPOSED SURFACES AND CONTROL ALL RUNOFF DURING CONSTRUCTION. SEDIMENT AND EROSION CONTROL MEASURES TO BE REMOVED AT COMPLETION OF PROJECT (FOLLOWING COMPLETION OF BASE ASPHALT AND SOD).
- MAINTAIN EROSION CONTROL MEASURES DURING CONSTRUCTION. ALL COLLECTED SEDIMENT TO BE DISPOSED OF AT AN APPROVED LOCATION.

PROPOSED WATER VALVE

- MINIMIZE AREA DISTURBED DURING CONSTRUCTION. ALL DEWATERING TO BE DISPOSED OF IN AN APPROVED SEDIMENTATION BASIN. PROTECT ALL CATCH BASINS, MANHOLES AND PIPE ENDS FROM SEDIMENT INTRUSION WITH GEOTEXTILE FABRIC (TERRAFIX 270 R), SILT SACKS, OR APPROVED EQUAL.
- KEEP ALL SUMPS CLEAN DURING CONSTRUCTION. PREVENT WIND-BLOWN DUST. 10. STRAW BALES TO BE USED IN LOCALIZED AREAS AS DIRECTED BY THE ENGINEER DURING CONSTRUCTION FOR WORKS WHICH ARE IN OR ADJACENT TO FLOOD LINES,
- 11. STRAW BALES TO BE TERMINATED BY ROUNDING BALES TO CONTAIN AND FILTER RUNOFF. 12. OBTAIN APPROVAL FROM THE SAINT CLAIR REGION CONSERVATION AUTHORITY (SCRCA) PRIOR TO CONSTRUCTION FOR WORKS WHICH ARE IN, OR ADJACENT TO FLOOD
- LINES. FILL LINES AND HAZARDOUS SLOPES. ALL SILT FENCING AND DETAILS ARE AT THE MINIMUM TO BE CONSTRUCTED IN ACCORDANCE WITH THE MINISTRY OF NATURAL RESOURCES GUIDELINES ON EROSION AND SEDIMENT CONTROL FOR URBAN CONSTRUCTION SITES.
- 14. 14. ALL OF THE ABOVE NOTES AND ANY SEDIMENT & EROSION CONTROL MEASURES ARE AT THE MINIMUM TO BE IN ACCORDANCE WITH THE MINISTRY OF NATURAL RESOURCES GUIDELINES ON EROSION AND SEDIMENT CONTROL FOR URBAN CONSTRUCTION SITES.

LEGEND:

FILL LINES AND HAZARDOUS SLOPES.

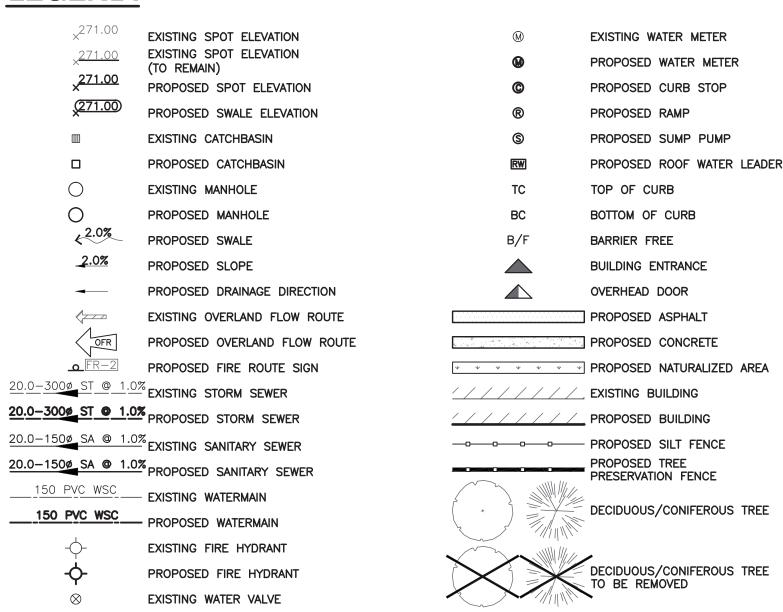

LEGAL INFORMATION

BLOCK 'L' REGISTERED PLAN No. 314 (SA)

CITY OF SARNIA COUNTY OF LAMBTON

TEMPORARY SITE BENCHMARK

MONUMENT TYPE: FINISHED FLOOR ELEVATION

LOCATION: THE FINISHED FLOOR ELEVATION OF THE EXISTING HOLY TRINITY CATHOLIC SCHOOL.

*ELEVATION: 184.150m

*ELEVATIONS SHOWN ARE SITE SPECIFIC AND MAY NOT NECESSARILY BE GEODETIC.


REFERENCE DOCUMENTS:


- 1. LEGAL INFORMATION OBTAINED FROM PLAN BY MONTHEITH & SUTHERLAND LIMITED, FILE No. SAR-4427, DATED JUNE 29, 2. EXISTING AREA TOPOGRAPHICAL INFORMATION OBTAINED FROM SURVEY COMPELTED BY STRIK, BALDINELLI, MONIZ LTD. ON
- MAY 5, 2016, FILE No. SBM-16-0722. 3. PROPOSED SITE PLAN INFORMATION OBTAINED FROM PLANS PROVIDED BY RANDY WILSON ARCHITECT INCORPORATED. FILE No. 1601, DATED, 04/14/2016.


LIST OF COMMON STANDARD DETAILS:


ONTARIO PROVINCIAL STANDARDS:
OPSD 219.110 LIGHT-DUTE SILT FENCE BARRIER


- OPSD 310.010 OPSD 400.020 CONCRETE SIDEWALK
- OPSD 608.010
- OPSD 703.021
- OPSD 2200.011 RAISED CONCRETE FOOTING FOR BASE MOUNTED LIGHTING POLES OPSD 2215.030 POLE MOUNTING DETAILS FOR BASE MOUNTED METAL POLE

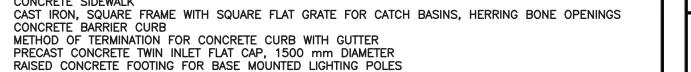

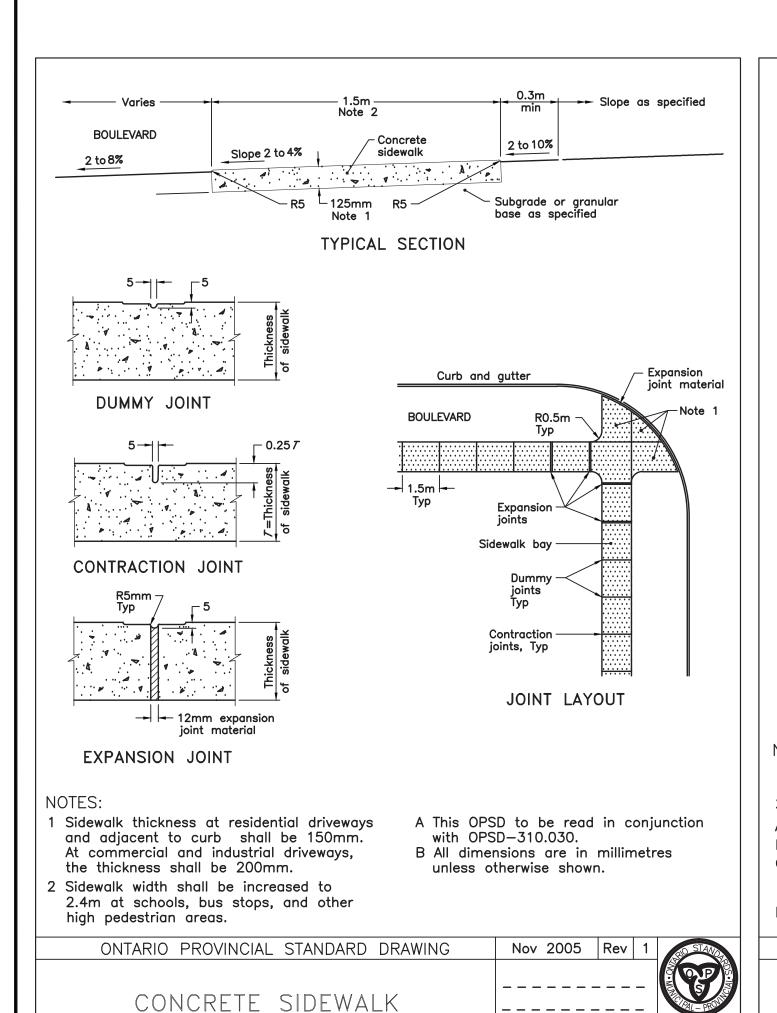

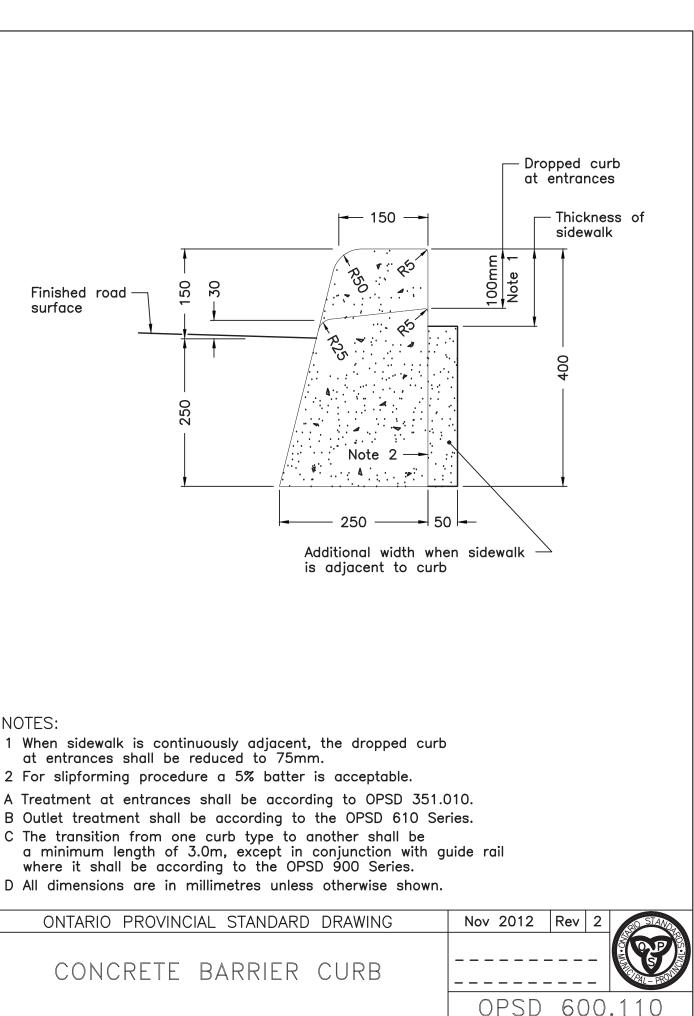


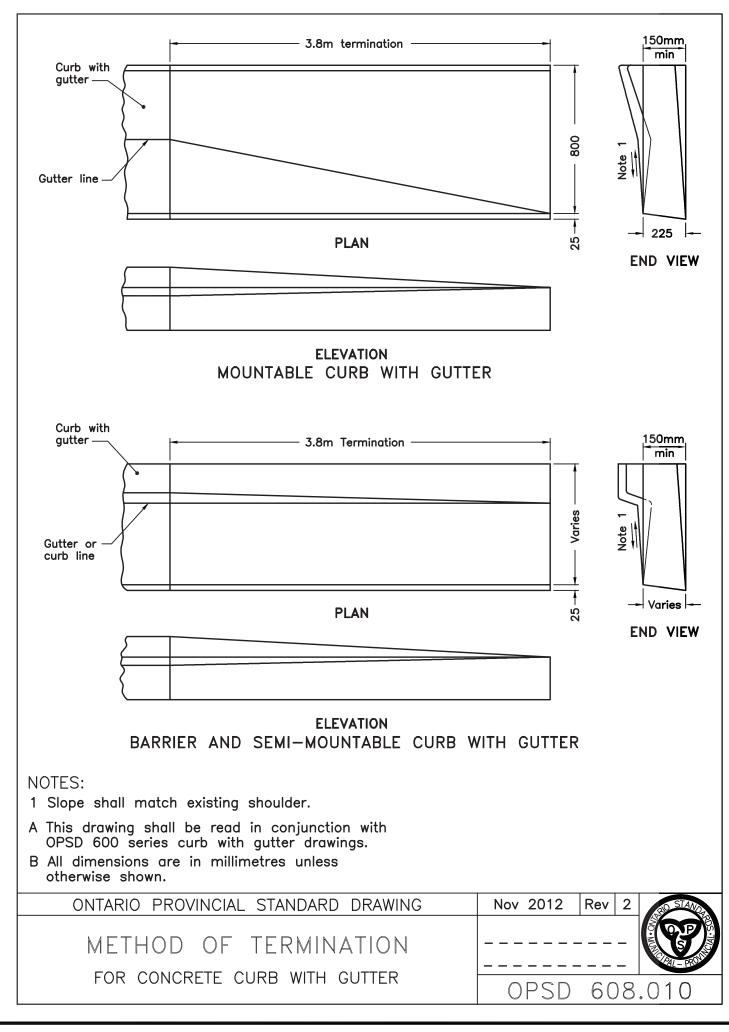

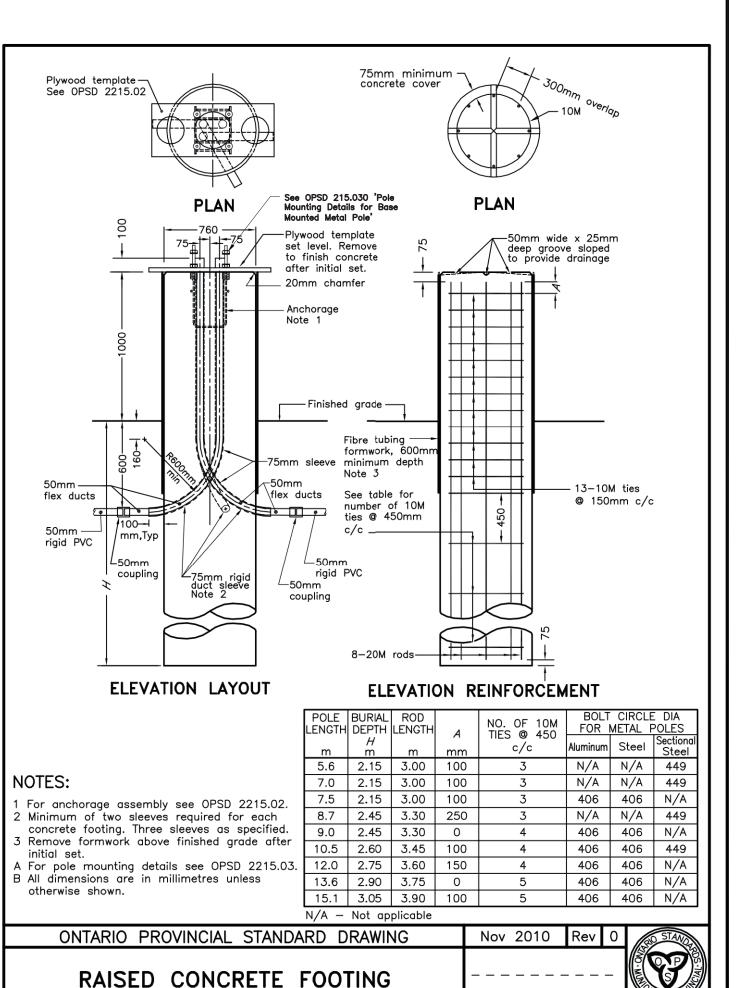


FOR BASE MOUNTED LIGHTING POLES



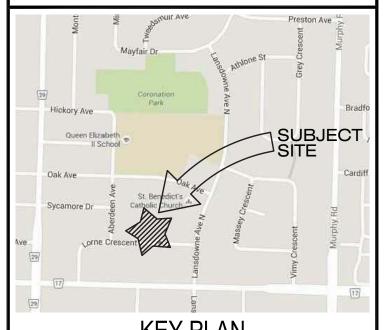

KEY PLAN

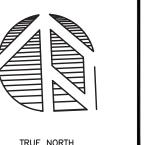




NOTES

LIST OF DRAWINGS

SHEET C1 NOTES, LEGEND & DETAILS PARTIAL SITE ENGINEERING PLANS SHEET C2

05/12/2016 ISSUED FOR ADDENDUM No. 1

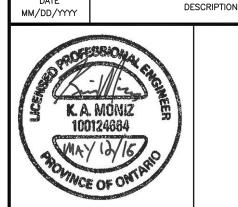


HOLY TRINITY ELM. SCHOOL PROP. PARKING LOT ADDITION **60 LORNE CRESCENT** SARNIA, ON.

DRAWING TITLE:

OPSD 2200.011

NOTES, LEGEND & DETAILS **PLANS**

DATE PLOTTED: 05/12/2016 9:43 AM	DRAWN: KEK	DRAWING No.
SCALE:	CHECKED: KAM	C
PROJECT No.		

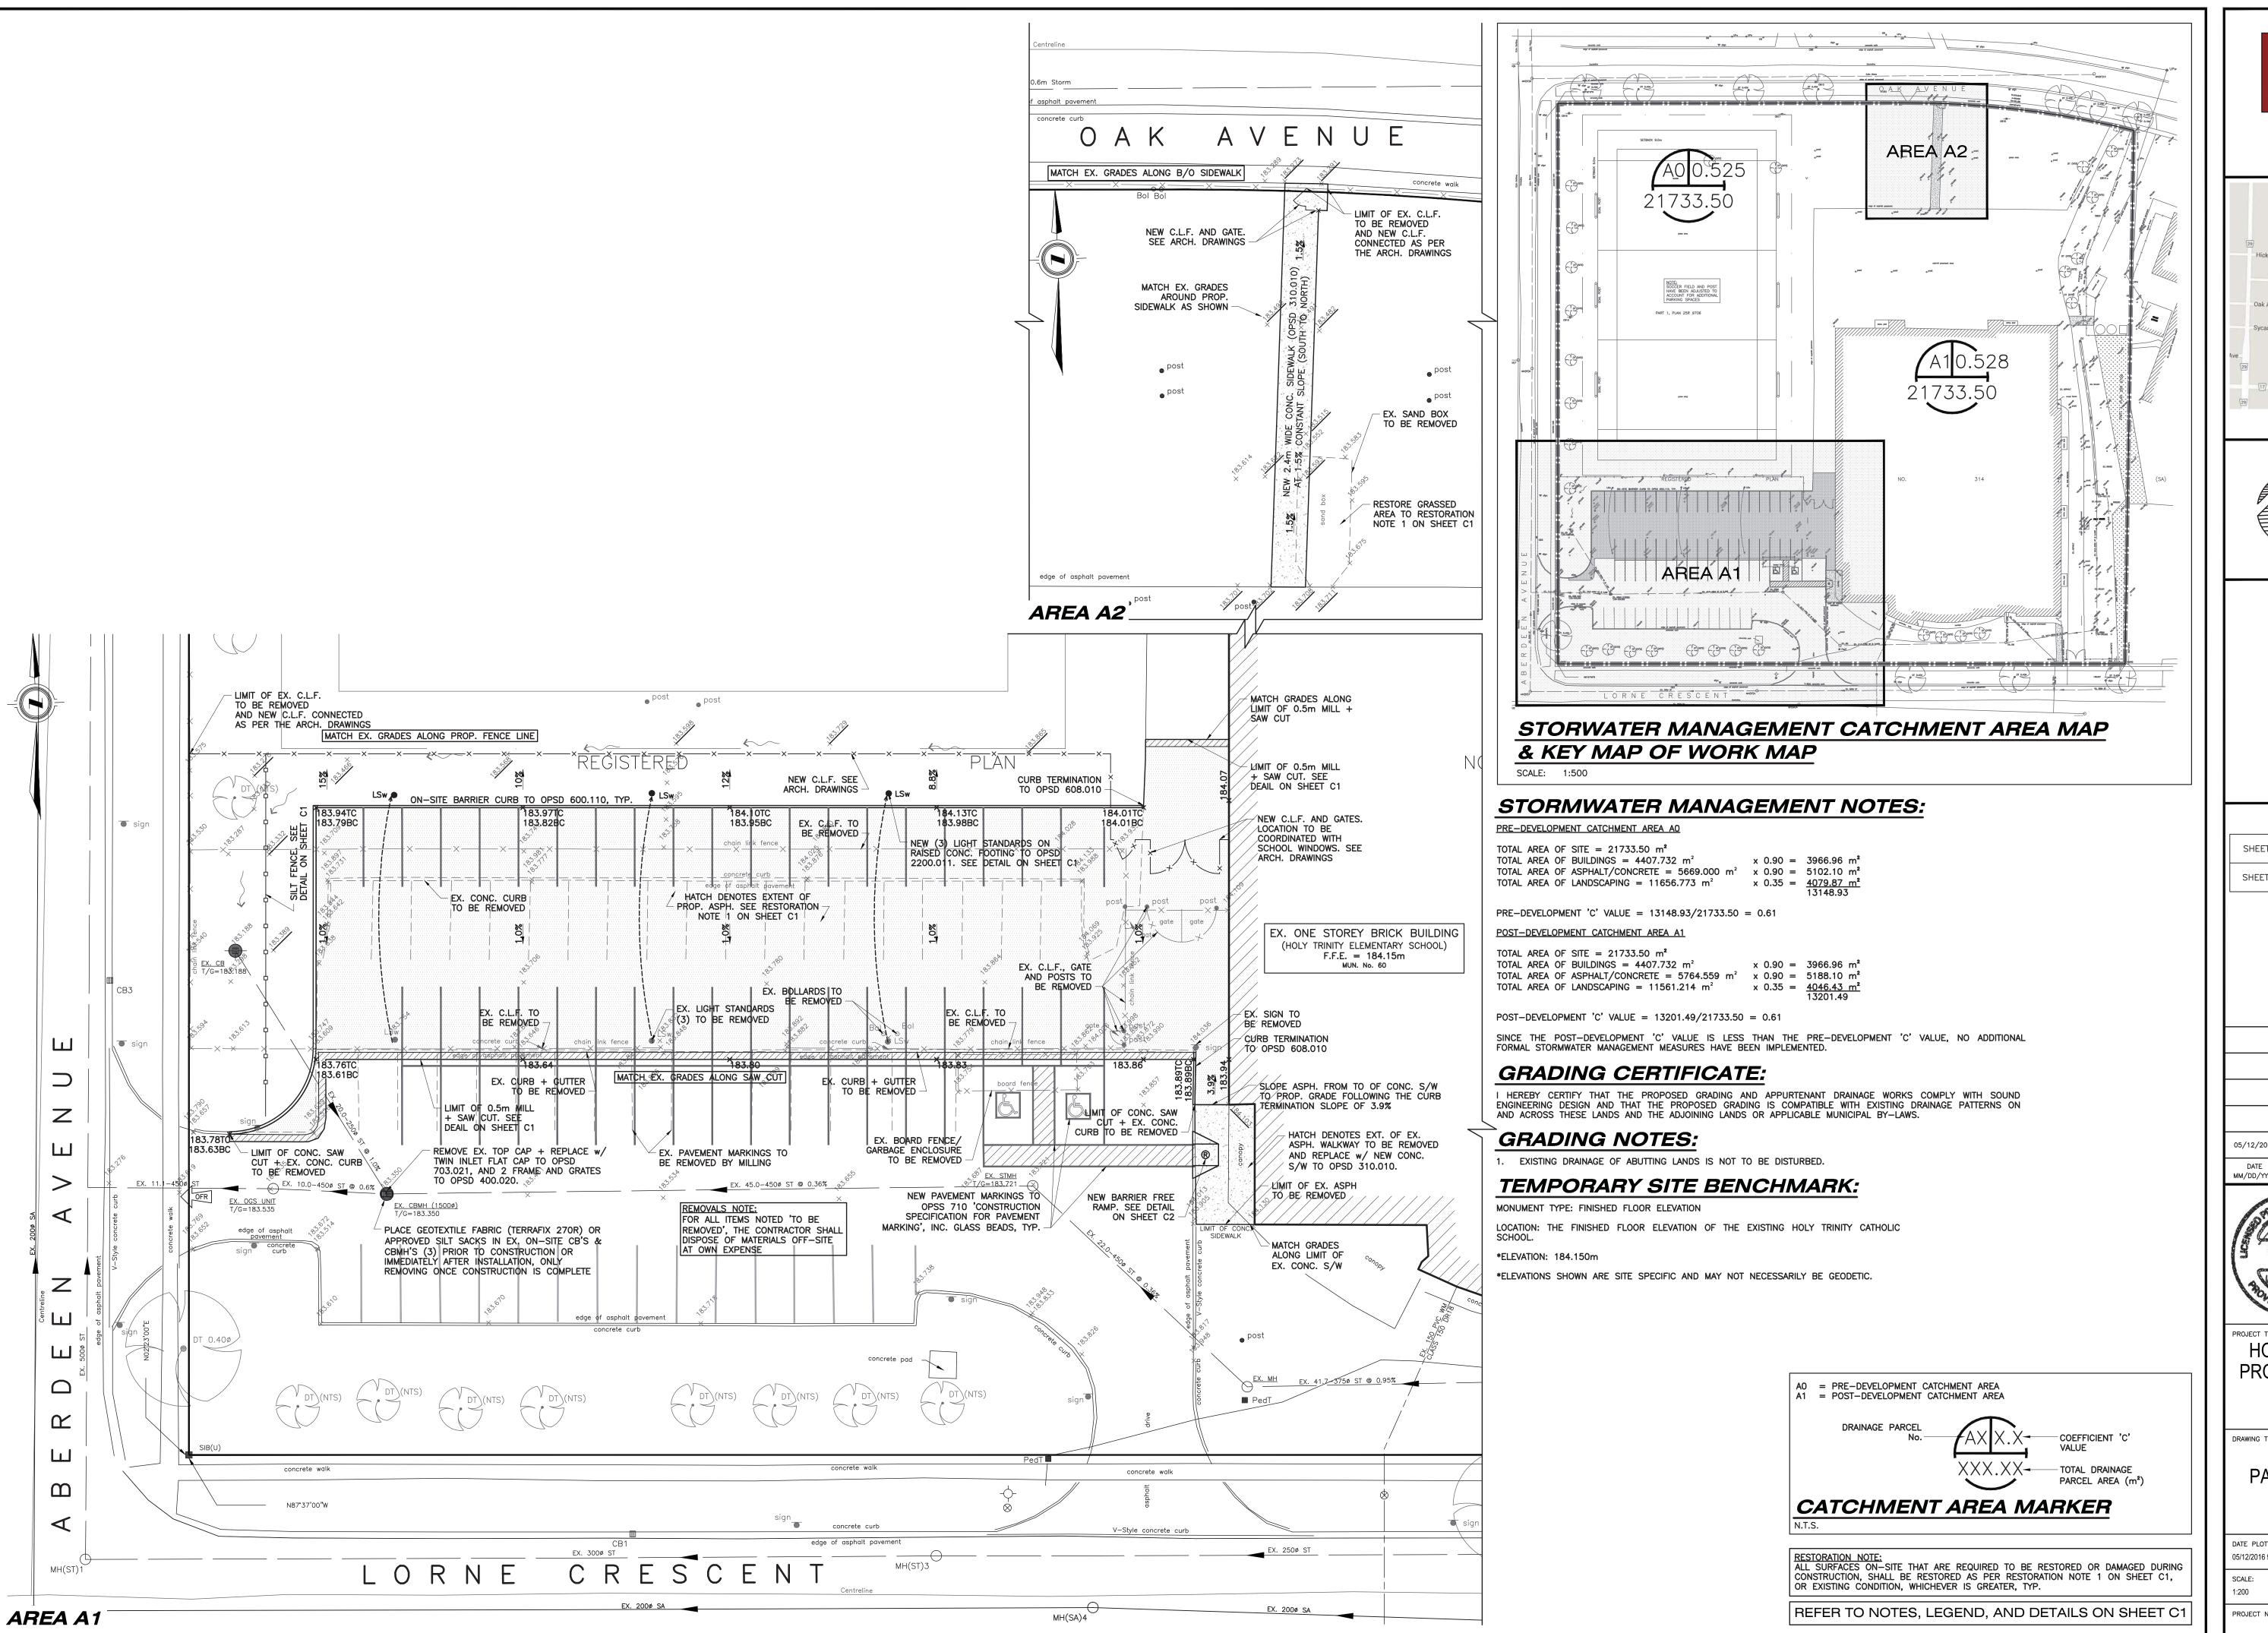









TRUE NORTH



CONSTRUCTION NORTH

NOTES

LIST OF DRAWINGS

NOTES, LEGEND & DETAILS SHEET C1 PARTIAL SITE ENGINEERING PLANS

ISSUED FOR ADDENDUM No. 1 05/12/2016 DESCRIPTION MM/DD/YYYY



HOLY TRINITY ELM. SCHOOL PROP. PARKING LOT ADDITION **60 LORNE CRESCENT** SARNIA, ON.

DRAWING TITLE:

PARTIAL SITE ENGINEERING **PLANS**

DATE PLOTTED: 05/12/2016 9:43 AM	DRAWN: KEK	DRAWING No.
SCALE: 1:200	CHECKED: KAM	C2
PROJECT No.		